## PLUMBING SPECIFICATIONS

#### 1.00 - GENERAL PROVISIONS

- 1.01 PROVIDE ALL LABOR, MATERIAL AND EQUIPMENT FOR A COMPLETE AND PROPERLY OPERATING PLUMBING SYSTEM.
- 1.02 CODES AND STANDARDS: ALL PLUMBING WORK SHALL BE IN STRICT COMPLIANCE WITH THE 2017 FLORIDA PLUMBING CODE AND ALL LOCAL CODES HAVING JURISDICTION.
- 1.03 ALL PLUMBING WORK SHALL BE DONE IN A NEAT AND WORKMANLIKE MANNER. CONTRACTOR SHALL SECURE AND PAY FOR ALL PERMITS AND FEES, ETC., REQUIRED FOR THE EXECUTION OF THIS WORK.
- 1.04 CONTRACTOR SHALL COORDINATE HIS WORK WITH ALL OTHER TRADES BEFORE FABRICATION OR INSTALLATION. OFFSETS AND/OR TRANSITIONS REQUIRED SHALL BE PROVIDED WITHOUT ADDITIONAL COST. CONTRACTOR SHALL COORDINATE AND INSTALL HIS WORK IN A TIMELY MANNER TO PREVENT DELAYS IN THE CONSTRUCTION.
- 1.05 CONTRACTOR SHALL BE RESPONSIBLE TO REPAIR OR REPLACE DAMAGED EQUIPMENT AND/OR MATERIAL.
- 1.06 PROVIDE ALL MATERIALS REQUIRED TO PROPERLY SUPPORT ALL PIPING AND EQUIPMENT. PIPE HANGERS SHALL BE ADJUSTABLE TYPE AND BE SPACED IN ACCORDANCE WITH THE FLORIDA PLUMBING CODE. PROVIDED PLASTIC COATED RING ON HANGERS FOR COPPER PIPING TO PROVIDE DIELECTRIC ISOLATION.
- 1.07 PROVIDE DIELECTRIC UNIONS OR FLANGES BETWEEN COPPER AND STEEL PIPING AND BETWEEN BRASSWARE AND STEEL. DO NOT USE STEEL AND COPPER PIPING IN THE SAME SYSTEM WITHOUT SUCH ISOLATION.
- 1.08 PROVIDE REDUCING FITTINGS (REDUCING BUSHINGS SHALL NOT BE USED) WHERE CHANGES IN PIPE SIZES OCCUR.
- 1.09 THIS CONTRACTOR SHALL SUPPLY AND INSTALL ALL SERVICES THROUGHOUT THE BUILDING AND MAKE CONNECTION TO SITE UTILITIES APPROXIMATELY 5'-0" OUTSIDE THE BUILDING. CONTRACTOR SHALL SUPPLY AND INSTALL FIXTURES, FITTINGS, VALVING AND TRIM AND MAKE READY FOR USE ALL FIXTURES, EQUIPMENT, ETC.
- 1.10 SEE ARCHITECTURAL DRAWINGS FOR FIXTURE LOCATIONS AND MOUNTING HEIGHTS.

2.00 - BASIC MATERIALS AND METHODS

- 2.01 DOMESTIC WATER ABOVEGROUND WATER PIPE AND FITTINGS TYPE "L" COPPER.
- 2.02 PROVIDE UNIONS OR FLANGES IN ALL DOMESTIC WATER SERVICE LINES AT EACH PIECE OF EQUIPMENT, SPECIALTY VALVES OR AT OTHER LOCATIONS REQUIRED FOR READY DISCONNECT.
- 2.03 WATER HAMMER ARRESTORS SHALL BE INSTALLED AT THE LOCATIONS ON THE PLANS AND IN ACCORDANCE WITH PDI STANDARD WH-201. PRODUCTS SHALL BE EQUAL TO THOSE MANUFACTURED BY PRECISION PLUMBING PRODUCTS OR SIOUX CHIEF.
- 2.04 VALVES: PROVIDE VALVES TO ISOLATE EACH RISER, BRANCH LINE AND PIECE OF EQUIPMENT.
- 2.05 PROVIDE PRESSURE REDUCING VALVE AND AIR GAP CONNECTION AT DISHWASHER AS REQUIRED BY CODE AND ACCORDING TO MANUFACTURER.
- 2.06 PROVIDE INLINE WATER FILTER AT COFFEE MAKER AND ICE MAKER TO REMOVE MATERIALS, TASTE AND ODOR -"EVERPURE OR "SYSTEMS IV".
- 2.07 SANITARY WASTE (NON-PRESSURE), SANITARY VENT AND STORM PIPING ABOVE GROUND NO-HUB CAST IRON SOIL PIPE AND FITTINGS PER CISPI 301 WITH HEAVY DUTY SHIELDED STAINLESS STEEL COUPLINGS.
- 2.08 CONDENSATE PIPING DWV COPPER OR NO-HUB CAST IRON SOIL PIPE AND FITTINGS PER CISPI 301 WITH HEAVY DUTY SHIELDED STAINLESS STEEL COUPLINGS.
- 2.09 INSTALL GRAVITY LINES SLOPED AT 1/8" PER FOOT FOR PIPE 3" AND LARGER AND 1/4" PER FOOT FOR PIPE SMALLER THAT 3". VERIFY INVERT ELEVATION WITH EXISTING PIPING PRIOR TO ANY PIPE BEING INSTALLED.
- PROVIDE AND PROPERLY LOCATE HANGERS TO ADEQUATELY SUPPORT PIPING. ARRANGE HANGERS TO PERMIT 2.10 EXPANSION AND CONTRACTION. DO NOT HANG PIPING FROM FIRE OR SMOKE WALLS. PROVIDE PIPE HANGERS AT EACH VALVE, STRAINER, AND OTHER PIPING ACCESSORY, AND AT EACH CHANGE OR DIRECTION.
- THE SIZE OF HANGERS FOR NON-INSULATED PIPES SHALL BE SUITABLE FOR THE PIPE SIZE TO BE SUPPORTED. FOR INSULATED PIPING, THE SIZE OF THE HANGER SHALL BE SUITABLE FOR THE PIPE SIZE, PLUS THE INSULATION AND INSULATION SHIELD.
- 2.12 SPACING: LOCATE PIPE SUPPORTS AS INDICATED IN THE FOLLOWING TABLE:

HORIZONTAL PIPE HANGER SCHEDULE					
MATERIAL	PIPE SIZE	HANGER SPACING			
COPPER TUBING	UP TO 1 1/4 INCH 1 1/2 INCH AND ABOVE	6 FOOT CENTERS 10 FOOT CENTERS			
CAST IRON PIPE	ALL	5 FOOT CENTERS			

3.00 - PLUMBING FIXTURES AND TRIM

- 3.01 ALL PLUMBING FIXTURES SHALL BE "FIRST QUALITY" AS DEFINED AND SET FORTH IN COMMERCIAL STANDARD CS77-28 AS PROMULGATED BY THE U.S. DEPARTMENT OF COMMERCE.
- 3.02 ALL FIXTURES ARE TO BE WHITE VITREOUS CHINA UNLESS OTHERWISE SPECIFICALLY NOTED. FIXTURES AND FITTINGS PROPOSED SHALL BE FROM ONE MANUFACTURER AND OF SIMILAR CHARACTER IN ANY ROOM OR LOCATION. ESCUTCHEONS, HANDLES, ETC., ON THE DIFFERENT FIXTURES SHALL BE OF THE SAME DESIGN.
- PROVIDE FIXTURE CARRIERS AS RECOMMENDED BY FIXTURE MANUFACTURER AND/OR CONSTRUCTION METHOD. 3.03 3.04 PROVIDE ACCESS PANELS TO ALL VALVES WITHIN CHASES OR ABOVE NON-ACCESSIBLE CEILINGS. REFER TO ARCHITECTURAL DRAWINGS FOR CEILING TYPES.
- 3.05 FLOOR DRAIN TRAP SEALS SHALL HAVE AN APPROVED PRIMING DEVICE DESIGNED FOR THAT PURPOSE.
- 3.06 ALL CONCEALED TRAPS, PRIMERS, VALVES, CLEANOUTS, ETC. LOCATED IN TILED AREAS SHALL BE PROVIDED WITH AN ACCESS PANEL.

#### 4.00 - INSULATION

- 4.01 ABOVE GROUND COLD AND HOT WATER PIPING FIBERGLASS, ("THICKNESS, ASJ JACKET, DOUBLE SEALING LAP JOINT, 0.24 K AT 75°F. INSULATION AND ADHESIVES INSTALLED IN RETURN AIR PLENUMS SHALL HAVE A MAXIMUM FLAME SPREAD RATING OF 25 AND A MAXIMUM SMOKE DEVELOPED RATING OF 50.
- 4.02 ABOVE GROUND STORM PIPING FIBERGLASS, 1/2" THICKNESS, ASJ JACKET, DOUBLE SEALING LAP JOINT, 0.24 K AT 75° F. INSULATION AND ADHESIVES INSTALLED IN RETURN AIR PLENUMS SHALL HAVE A MAXIMUM FLAME SPREAD RATING OF 25 AND A MAXIMUM SMOKE DEVELOPED RATING OF 50.
- 4.03 ABOVEGROUND CONDENSATE PIPING SHALL BE 1/2" FLEXIBLE UNICELLULAR POLYOLEFIN FOAM AND SHALL HAVE A MAXIMUM FLAME SPREAD RATING OF 25 AND A MAXIMUM SMOKE DEVELOPED RATING OF 50-IMCOA "IMCOLOCK".

5.00 - VALVES AND COCKS

- 5.01 VALVES 2" AND SMALLER SHALL BE BALL VALVES. 150 PSI SWP, 400 PSI WOG. STANDARD PORT BALL, BRONZE TRIM. CAST BRONZE BODY, CHROMIUM-PLATED BRASS BALL, BRONZE NON-BLOWOUT STEM, TEFLON SEAT, DOUBLE O-RING STEM SEALS, ZINC-COATED STEEL HANDLE WITH PLASTIC COATED HAND GRIP, 90 DEGREE OPERATION FROM FULL OPEN TO TIGHT SHUT-OFF - STOCKHAM S214-BR-T-T, STOCKHAM S216-BR-T-S OR EQUAL.
- 5.02 CHECK VALVES, ROUGH BRASS, REGRINDING BRONZE DISC STOCKHAM B-345; B-309 OR EQUAL.

6.00 - STERILIZATION

DOMESTIC WATER PIPING SHALL BE THOROUGHLY FLUSHED OUT AND STERILIZED IN ACCORDANCE WITH THE FLORIDA PLUMBING CODE.

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## PLUMBING SYMBOL LEGEND

- DESCRIPTION
- COMPRESSED AIR
- ACID VENT - ACID WASTE
- BELOW GROUND ACID WASTE - ABOVE GROUND CONDENSATE DRAIN
- BELOW GROUND CONDENSATE DRAIN - DENTAL AIR
- DEIONIZED WATER
- DENTAL VACUUM
- DOMESTIC COLD WATER
- DOMESTIC HOT WATER
- DOMESTIC HOT WATER RETURN
- FUEL OIL FILL
- FUEL OIL GAGE
- FUEL OIL RETURN
- FUEL OIL SUPPLY
- FUEL OIL VENT
- GAS
- KITCHEN WASTE (GREASE) - MEDICAL COMPRESSED AIR
- MEDICAL VACUUM
- NITROGEN
- NITROUS OXIDE - OXYGEN
- ABOVE GROUND SANITARY
- BELOW GROUND SANITARY
- SANITARY VENT
- ABOVE GROUND STORM
- BELOW GROUND STORM
- OVERFLOW STORM DRAIN
- BELOW GROUND OVERFLOW STORM
- SOFT COLD WATER
- VACUUM (AIR)
- WASTE OIL
- WASTE OIL VENT
- WATER METER
- HOSE BIBB OR WALL HYDRANT - CLEAN OUT PLUG
- WALL CLEANOUT
- WALL CLEANOUT
- FLOOR CLEAN OUT
- FLOOR DRAIN
- ROOF DRAIN
- FLOOR SINK
- SHUT-OFF VALVE IN VALVE BOX
- SHUTOFF VALVE
- BALL VALVE - CALIBRATED BALANCING VALVE
- CHECK VALVE (SWING)
- PRESSURE REDUCING VALVE
- SOLENOID OPERATED VALVE
- REDUCED PRESSURE BACKFLOW PREVENTER
- RELIEF OR SAFETY VALVE
- GAS COCK
- GAS PRESSURE REGULATOR
- SHUTOFF VALVE ON RISER
- GAS COCK ON RISER
- CONNECTION, TOP
- CONNECTION, BOTTOM
- ELBOW, TURNED DOWN
- ELBOW, TURNED UP - TEE, TURNED UP

- CAP

YMBOL LEGEND	PLUMBING ABBREVIATIONS		GENERA	
DESCRIPTION	SYMBOL	DESCRIPTION	1.	REFERENCE THE SPECIFICATIONS FOR MATERIAL AND EQUIPMENT
- COMPRESSED AIR - ACID VENT	CA AFF AW	- COMPRESSED AIR - ABOVE FINISH FLOOR - ACID WASTE	2	INSTALLATION STANDARDS. THE PLUMBING INSTALLATION SHALL COMPLY WITH ALL STATE AND LOCAL
- ACID WASTE	AV CB	- ACID VENT - CATCH BASIN		CODES.
- BELOW GROUND ACID WASTE - ABOVE GROUND CONDENSATE DRAIN	CD CFH	- CONDENSATE DRAIN - CUBIC FEET PER HOUR	3.	UTILITIES AND SERVICES INDICATED ARE TAKEN FROM VARIOUS OLD AND NEW SURVEYS, AS-BUILT RECORDS AND FIELD INVESTIGATIONS. UNFORESEEN
- BELOW GROUND CONDENSATE DRAIN	CO CONT	- CLEANOUT - CONTINUATION		CONDITIONS PROBABLY EXIST AND NEW WORK MAY NOT BE FIELD LOCATED EXACTLY AS SHOWN ON DRAWINGS. COOPERATION WITH OTHER TRADES IN
- DENTAL AIR - DEIONIZED WATER	CW X-CW	- DOMESTIC COLD WATER - EXISTING COLD WATER		ROUTING AND BURIAL DEPTHS, AS DETERMINED DURING CONSTRUCTION, WILL BE NECESSARY.
- DENTAL VACUUM	DI DN DS	- DEIONIZED WATER - DOWN - DOWNSPOUT	4.	FIELD VERIFY EXISTING INSTALLATIONS. MODIFY EXISTING PLUMBING SYSTEMS, WHICH ARE TO REMAIN ACTIVE, TO FACILITATE RECONNECTION
- DOMESTIC COLD WATER - DOMESTIC HOT WATER	DWG EXIST	- DRAWING - EXISTING		AND EXTENSION OF THE NEW WORK.
- DOMESTIC HOT WATER RETURN	°F FCO	- DEGREE FAHRENHEIT - FLOOR CLEANOUT	5.	NOTIFY OWNER AT LEAST 48 HOURS PRIOR TO INTERRUPTING EXISTING SERVICE. SCHEDULE DISCONNECTION AND TIE-INS TO MINIMIZE DISRUPTION
- FUEL OIL FILL - FUEL OIL GAGE	FD FOF	- FLOOR DRAIN - FUEL OIL FILL		OF SERVICES. SERVICES ARE NOT TO BE LEFT DISRUPTED DURING NON- NORMAL CONTRACTOR WORKING HOURS. CONTRACTOR SHALL OBTAIN
- FUEL OIL RETURN	FOG FOR	- FUEL OIL GAGE - FUEL OIL RETURN		WRITTEN APPROVAL FOR INTERRUPTION OF SERVICE.
- FUEL OIL SUPPLY - FUEL OIL VENT	FOS FOV FS	- FUEL OIL SUPPLY - FUEL OIL VENT - FLOOR SINK	0.	PLANS ARE NOT COMPLETELY TO SCALE. PIPE ROUTING SHOWN IS SCHEMATIC AND IS NOT INTENDED TO INDICATE EXACT ROUTING. CONTRACTOR SHALL PROVIDE ANY ADDITIONAL OFFSETS AND FITTINGS
- GAS	G GPH	- GAS - GALLONS PER HOUR		REQUIRED FOR PROPER INSTALLATION AND TO MAINTAIN CLEARANCES. VERIFY STRUCTURAL, MECHANICAL AND ELECTRICAL INSTALLATIONS AND
- KITCHEN WASTE (GREASE) - MEDICAL COMPRESSED AIR	GPM GR	- GALLONS PER MINUTE - KITCHEN WASTE (GREASE)		OTHER POTENTIAL OBSTRUCTIONS AND ROUTE PIPING TO AVOID INTERFERENCES.
- MEDICAL VACUUM	HB HD	- HOSE BIBB - HUB DRAIN	7.	PROVIDE ALL OFFSETS AND FITTINGS AND MAKE CONNECTION TO SITE
- NITROGEN - NITROUS OXIDE	HW X-HW	- DOMESTIC HOT WATER - EXISTING DOMESTIC HOT WATER		
- OXYGEN	HWR X-HWR IE	- DOMESTIC HOT WATER RECIRCULATING - EXISTING DOMESTIC HOT WATER RECIRCULATING - INVERT ELEVATION	8.	CONCEAL PIPING ABOVE CEILINGS, WITHIN WALLS OR CHASES EXCEPT IN MECHANICAL ROOMS OR AS SPECIFICALLY NOTED.
- ABOVE GROUND SANITARY - BELOW GROUND SANITARY	IW KW	- INVERTELEVATION - INDIRECT WASTE - KILOWATT	9.	PROVIDE ACCESS PANELS FOR ALL VALVES CONCEALED IN WALLS OR ABOVE NON-ACCESSIBLE CEILINGS.
- SANITARY VENT	LBS MA OR A	- POUNDS - MEDICAL AIR	10	. SLEEVE AND/OR FIRESTOP ALL PENETRATIONS THROUGH RATED WALLS,
- ABOVE GROUND STORM - BELOW GROUND STORM	MV 0R V MH	- MEDICAL VACUUM - MANHOLE		CEILINGS, AND FLOORS WITH U/AL LISTED ASSEMBLIES. FIRESTOP ASSEMBLIES SHALL BE EQUAL TO OR EXCEED THE RATING OF THE WALL,
- OVERFLOW STORM DRAIN	NI OR N N20	- NITROGEN - NITROUS OXIDE		CEILING OR FLOOR. SEE ARCHITECTURAL DRAWINGS FOR FINAL FINISHES.
- BELOW GROUND OVERFLOW STORM	NC NIC	- NORMALLY CLOSED - NOT IN CONTRACT		. FLASH AND COUNTER-FLASH ROOF PENETRATIONS.
- SOFT COLD WATER - VACUUM (AIR)	NO NP	- NORMALLY OPEN - NON-POTABLE WATER	12	. WHEN BEAM SLEEVE PENETRATIONS ARE NECESSARY, COORDINATE PENETRATIONS WITH ALL TRADES, THE ARCHITECT AND THE STRUCTURAL ENGINEER.
- WASTE OIL	NTS OD OX OR O	- NOT TO SCALE - OUTSIDE DIAMETER - OXYGEN	13	PROVIDE FOUNDATION PAD PENETRATION SLEEVES. ALLOW 1" MINIMUM
- WASTE OIL VENT - WATER METER	PRV	- PRESSURE REDUCING VALVE - POUNDS PER SQUARE INCH	10	CLEARANCE BETWEEN SLEEVE INSIDE SURFACE AND PIPE EXTERIOR.
- HOSE BIBB OR WALL HYDRANT	PVC RD	- POLYVINYL CHLORIDE PIPE - ROOF DRAIN	14	. SEE ARCHITECTURAL DRAWINGS FOR FIXTURE LOCATIONS AND MOUNTING HEIGHTS.
- CLEAN OUT PLUG	RPBP SAN	- REDUCED PRESSURE BACKFLOW PREVENTER - SANITARY	15	. PROVIDE AUTOMATIC TRAP PRIMERS FOR FLOOR DRAIN TRAP SEALS. TRAP
- WALL CLEANOUT - WALL CLEANOUT	X-S SD	- EXISTING SANITARY - STORM DRAIN		PRIMERS ARE NOT REQUIRED ON FLOOR DRAINS RECEIVING CONTINUOUS CONDENSATE OR LOCATED IN SHOWERS. SEE FLOOR PLANS FOR ADDITIONAL
- FLOOR CLEAN OUT	SF SH ST	- SQUARE FEET - SHEET - STORM	16	INFORMATION.
- FLOOR DRAIN	STO SW	- OVERFLOW STORM DRAIN - SOFT COLD WATER	10	FIXTURES, DEVICES, APPLIANCES AND APPARATUS.
- ROOF DRAIN	V X-V	- VENT - EXISTING VENT	17	. ALL EXPOSED PIPE AND FITTINGS IN FINISHED AREAS SHALL BE CHROME PLATED.
- FLOOR SINK - SHUT-OFF VALVE IN VALVE BOX	VAC VC	- VACUUM - VACUUM CLEANING	18	. MOUNT WALL HYDRANTS 24" ABOVE FINISHED GRADE UNLESS SPECIFICALLY
- SHUTOFF VALVE	VTR WCO	- VENT THRU ROOF - WALL CLEANOUT		NOTED OTHERWISE ON DRAWINGS. MOUNT HOSE BIBBS 24" ABOVE FINISHED FLOOR UNLESS SPECIFICALLY NOTED OTHERWISE ON DRAWINGS.
- BALL VALVE	WTR	- WATER	19	. PROVIDE CLEANOUTS IN ACCORDANCE WITH ALL STATE AND LOCAL CODES. INSTALL CLEANOUT WITH COVER FLUSH TO FINISH SURFACE. PROVIDE WALL
- CALIBRATED BALANCING VALVE - CHECK VALVE (SWING)				CLEANOUTS AT THE BASE OF EACH SANITARY AND STORM DRAIN STACK. WALL CLEANOUTS SHALL BE MOUNTED 24" ABOVE FINISHED FLOOR. FLOOR
- PRESSURE REDUCING VALVE		BLE CODES AND STANDARDS		CLEANOUTS SHALL NOT BE LOCATED IN PUBLIC AREAS UNLESS SHOWN OTHERWISE ON DRAWINGS.
- SOLENOID OPERATED VALVE - REDUCED PRESSURE BACKFLOW PREVENTER			20	. COORDINATE EXACT FLOOR DRAIN LOCATIONS WITH ARCHITECTURAL
- RELIEF OR SAFETY VALVE		WITHIN THESE DOCUMENTS SHALL BE IN FULL		DRAWINGS. SET FLOOR DRAINS BELOW FINISHED FLOOR TO ALLOW FOR FLOOR SLOPING TO THE DRAIN.
- GAS COCK		L FEDERAL, STATE AND LOCAL CODES AND STANDARDS IMITED TO THE FOLLOWING.	21	. COORDINATE PIPING WITH ALL ELECTRICAL EQUIPMENT (PANELS, TRANSFORMERS, ETC.) PRIOR TO ANY INSTALLATION. DO NOT ROUTE ANY
- GAS PRESSURE REGULATOR	1. INTERNATIONAL B AMENDMENTS	UILDING CODE, 2018 EDITION, WITH GEORGIA		PIPING OVER ANY ELECTRICAL PANELS UNDER ANY CIRCUMSTANCES. ANY PIPING RUN OVER PANELS SHALL BE RE-ROUTED AT NO ADDITIONAL COST.
- SHUTOFF VALVE ON RISER - GAS COCK ON RISER	(2020)	ESIDENTIAL CODE, 2018 EDITION, WITH GEORGIA	22	ALL WALL MOUNTED LAVATORIES SHALL BE ATTACHED TO FLOOR MOUNTED
- CONNECTION, TOP	AMENDMENTS (202			CARRIER DESIGNED TO WITHSTAND A VERTICAL LOAD OF 250 POUNDS ON THE FRONT OF THE FIXTURE.
- CONNECTION, BOTTOM - ELBOW, TURNED DOWN		LUMBING CODE, 2018 EDITION, WITH GEORGIA	23	PROVIDE SANITARY WASTE, VENT, DOMESTIC WATER, ETC. ROUGH-IN AND
- ELBOW, TURNED UP	AMENDMENTS(202 5. INTERNATIONAL M AMENDMENTS	0) ECHANICAL CODE, 2018 EDITION, WITH GEORGIA		MAKE FINAL CONNECTIONS (TO INCLUDE PROVIDING ALL NECESSARY RELATED STOPS, VALVES, TRAPS, ETC. AND MAKE READY FOR USE) TO ALL EQUIPMENT, WHETHER FURNISHED BY THIS CONTRACTOR OR FURNISHED BY
- TEE, TURNED UP	(2020)	JEL GAS CODE 2018 EDITION, WITH GEORGIA		OTHERS.
- TEE, TURNED DOWN - CAP	AMENDMENTS (202		24	. PROVIDE CERTIFIED COPY OF MEDICAL GAS TEST REPORT AT FINAL A.H.C.A. INSPECTION.
- DIRECTION OF FLOW	SUPPLEMENTS AN AMENDMENTS (202	D 20)	25	. REFER TO ALL CONSULTANTS CONSTRUCTION DOCUMENTS INCLUDING FOOD
- ALARM PANEL	2018	OTECTION ASSOCIATION (NFPA) 101, LIFE SAFETY CODE,		SERVICE, MEDICAL EQUIPMENT AND INTERIOR DESIGN CONSULTANT AS ADDITIONAL PLUMBING REQUIREMENTS ARE CONTAINED WITHIN THEIR
- MASTER ALARM PANEL		TE AMENDMENTS (2020) ICAL CODE, 2017 EDITION		CONSTRUCTION DOCUMENTS. CONTRACTOR SHALL REFER TO ARCHITECTURAL DRAWINGS AND SPECIFICATIONS FOR ADA REQUIREMENTS.
- MEDICAL GAS OUTLET - MEDICAL GAS VALVE BOX			26	. CONTRACTOR SHALL BE RESPONSIBLE FOR LOCATING AND VERIFYING ALL EXISTING UTILITIES BELOW GRADE PRIOR TO CONSTRUCTION. CONTRACTOR
- CONNECT TO EXISTING				SHALL COORDINATE WITH THE UTILITY COMPANIES TO RELOCATE ANY EXISTING UTILITIES THAT MAY INTERFERE WITH THE PROPOSED
- DEMOLISH TO POINT INDICATED				CONSTRUCTION. CONTRACTOR SHALL CALL "FLORIDA ONE CALL" AT 1-800- SUN-SHINE 48 HOURS BEFORE DIGGING. CONTRACTOR SHALL COORDINATE
- REVISION REFERENCE				WITH GEORGIA 811.
- DETAIL REFERENCE: TOP-DETAIL#, BOTTOM-DRAWING# SHOWN ON			27	. SANITARY DRAINAGE PIPING IN KITCHENS SHALL BE SERVICE WEIGHT CAST- IRON PIPING AND FITTINGS UNLESS SPECIFICALLY NOTED OTHERWISE ON
			20	DRAWINGS.
			28	SANITARY DRAINAGE PIPING THAT RECEIVES HIGH TEMPERATURE WASTE (120 F OR GREATER) SHALL BE SERVICE WEIGHT CAST-IRON PIPING AND FITTINGS.
			29	. DOUBLE COMBINATIONS, DOUBLE "Ys" AND SANITARY CROSSES SHALL NOT BE USED IN SANITARY OR STORM DRAINAGE SYSTEMS.
			30	. MEDICAL GAS ALARM PANELS AND ZONE VALVE BOXES SHALL BE MOUNTED
				AT 50" ABOVE FINISHED FLOOR TO TOP OF PANEL. MEDICAL GAS OUTLETS SHALL BE MOUNTED AT 50" ABOVE FINISHED FLOOR TO TOP OF OUTLET. MOUNTING HEIGHTS SHOWN ON ARCHITECTURAL DRAWINGS OR ESTABLISHED MOUNTING HEIGHTS IN EXISTING FACILITY SHALL TAKE PRIORITY OVER THE HEIGHTS LISTED. REFER TO VENDOR DRAWINGS FOR MOUNTING HEIGHT OF HEADWALL SYSTEMS CONTAINING MEDICAL GAS
			31	OUTLETS. . PROVIDE CHECK VALVES ON COLD AND HOT WATER SUPPLIES TO ALL MOP/SERVICE SINK FAUCETS, SENSOR FAUCETS, FOOT/KNEE OPERATED FAUCETS, 3-COMPARMENT SINK FAUCETS, CART WASH SUPPLIES, CAN WASH SUPPLIES, HOSE REELS AND PRIOR TO ALL MIXING VALVES. REFER TO
NOTE: SOME SYMBOLS SHOWN ON THIS LEGEND	MAY NOT PERTAIN TO TH	S PROJECT		SPECIFICATIONS FOR CHECK VALVES

## IERAL NOTES

- 32. BALANCE THE DOMESTIC HOT WATER SYSTEM AND THE HOT WATER RECIRCULATING SYSTEM SO EACH AREA SERVED MAINTAINS AN ADEQUATE FLOW OF HOT WATER THROUGHOUT THE SUPPLY PIPING NETWORK.
- 33. HOT WATER DISTRIBUTION SYSTEMS SERVING PATIENT/RESIDENT CARE AREAS SHALL BE UNDER CONSTANT RECIRCULATION. NON-RECIRCULATED FIXTURE BRANCH PIPING SHALL NOT EXCEED 25 FEET IN LENGTH. HOT WATER PIPING SERVING "PUBLIC" LAVATORIES SHALL NOT HAVE A DEAD-END EXCEEDING 2 FEET.
- 34. SANITARY PIPING 2" OR LESS SHALL BE INSTALLED AT 1/4" PER FOOT SLOPE. PIPING 3" AND LARGER SHALL BE INSTALLED AT 1/8" PER FOOT SLOPE UNLESS NOTED OTHERWISE. STORM PIPING SHALL BE INSTALLED AT 1/8" PER FOOT SLOPE.
- 35. SUBMITTALS: ELECTRONIC SUBMITTALS SHALL BE IN SEARCHABLE FORMAT. DO NOT SUBMIT SCANNED DOCUMENTS.
- 36. REVERSE OSMOSIS, DEIONIZED-WATER AND OTHER PROCESS WATER PIPING SHALL BE POLYPROPYLENE PIPE WITH HEAT-FUSION JOINTS. PIPING SHALL BE SCHEDULE 40, PIPE AND FITTINGS MADE TO ASTM D 2447.
- 37. A MINIMUM CLEARANCE OF 4 INCHES BETWEEN ALL CONDUITS, PIPING AND DUCT WORK THAT ARE PARALLEL OR ADJACENT TO ALL FIRE AND FIRE/SMOKE-RATED WALLS TO FACILITATE THE INSPECTION OF THESE WALL.
- 38. PROVIDE LIGHTNING PROTECTION ON ALL VTR'S, EXHAUST PIPES, AIR INTAKE PIPES, WATER HEATER FLUE'S AND INTAKES THAT EXTEND OVER 10" ABOVE FINISH ROOF AS REQUIRED BY CODE. COORDINATE WITH ELECTRICAL FOR ADDITIONAL INFORMATION.

## GENERAL GRAVITY DEMOLITION NOTES

- EXISTING CONDITIONS SHOWN ON THIS DRAWING ARE TAKEN FROM ORIGINAL DRAWINGS. ALL EXISTING CONDITIONS MUST BE VERIFIED PRIOR TO DEMOLITION. FIELD CONDITIONS SHALL GOVERN. FIELD VERIFY LOCATIONS OF EXISTING PIPING BEFORE DEMOLITION. PROVIDE ALL REQUIRED DEMOLITION WHETHER SHOWN ON THE PLANS OR NOT. COORDINATE WITH THE ARCHITECTURAL DRAWING FOR ITEMS NOT INDICATED. COORDINATE DEMOLITION OF EXISTING PIPING WITH NEW WORK. PIPING CONNECTING TO AREAS OUTSIDE OF RENOVATED SPACE SHALL NOT TO BE DISCONNECTED UNTIL AFTER NEW PIPING IS INSTALLED. COORDINATE SYSTEM SHUT DOWNS WITH THE FACILITY PRIOR TO DEMOLITION.
- ALL ITEMS REMOVED UNDER THIS PROJECT SHALL BE TURNED OVER TO THE OWNER. OR DISPOSED OF AT THE OWNER'S DISCRETION.
- ALL VENT PIPING INDICATED ON THIS DRAWING IS LOCATED IN THE CEILING SPACE OR WALL SPACES UNLESS NOTED OTHERWISE, FIELD VERIFY BEFORE CONSTRUCTION.
- ALL SANITARY PIPING INDICATED ON THIS DRAWING IS LOCATED BELOW THE FLOOR SLAB OR WALL CHASE UNLESS NOTED OTHERWISE. OFFSET ALL EXISTING SANITARY AND VENT RISERS FROM FLOOR ABOVE TO WALLS ON NEW FLOOR PLAN, FIELD VERIFY EXACT LOCATION AND PROVIDE REQUIRED OFFSET TO FACILITATE OPERATION OF PLUMBING SYSTEMS TO THE FLOORS ABOVE AND BELOW.
- CARE MUST BE TAKEN WHEN REMOVING PIPE AROUND LOAD BEARING WALLS. THE WALL OR FOOTING BELOW IS NOT TO BE DESTROYED.
- EXISTING ROOF DRAINS AND RAIN WATER LEADER PIPING TO REMAIN UNLESS OTHERWISE NOTED. FIELD VERIFY ROUTING OF EXISTING PIPING BEFORE CONSTRUCTION BEGINS. EXISTING RAIN WATER PIPING LOCATED IN WALLS TO BE REMOVED SHALL BE REROUTED OVER HEAD TO A NEW WALL LOCATION AND RECONNECTED TO THE UNDERGROUND STORM.
- CUT AND PATCH CEILINGS, WALLS AND FLOOR SLAB AS REQUIRED TO FACILITATE PLUMBING RENOVATION. SEE ARCHITECTURAL DRAWINGS FOR PATCHING DETAILS.
- EXISTING BUILDING DRAINS UNDER CONCRETE SLABS AND EXISTING BUILDING SEWERS THAT SERVES THE SYSTEM SHALL BE INTERNALLY EXAMINED TO VERIFY THAT THE PIPING IS SLOPING IN THE CORRECT DIRECTION, IS NOT BROKEN, IS NOT OBSTRUCTED AND IS SIZED FOR THE DRAINAGE LOAD OF THE NEW PLUMBING DRAINAGE SYSTEM TO BE INSTALLED.

## **GENERAL PRESSURE DEMOLITION NOTES**

- EXISTING CONDITIONS SHOWN ON THIS DRAWING ARE TAKEN FROM ORIGINAL DRAWINGS. ALL EXISTING CONDITIONS MUST BE VERIFIED PRIOR TO DEMOLITION. FIELD CONDITIONS SHALL GOVERN. FIELD VERIFY LOCATIONS OF EXISTING PIPING BEFORE DEMOLITION. PROVIDE ALL REQUIRED DEMOLITION WHETHER SHOWN ON THE PLANS OR NOT. COORDINATE WITH THE ARCHITECTURAL DRAWING FOR ITEMS NOT INDICATED. COORDINATE DEMOLITION OF EXISTING PIPING WITH NEW WORK. PIPING CONNECTING TO AREAS OUTSIDE OF RENOVATED SPACE SHALL NOT TO BE DISCONNECTED UNTIL AFTER NEW PIPING IS INSTALLED. COORDINATE SYSTEM SHUT DOWNS WITH THE FACILITY PRIOR TO DEMOLITION.
- ALL ITEMS REMOVED UNDER THIS PROJECT SHALL BE DISPOSED OF OR TURNED OVER TO THE OWNER AT THE OWNER'S DISCRETION.
- ALL WATER PIPING INDICATED ON THIS DRAWING IS LOCATED IN THE CEILING SPACE OR WALL SPACES UNLESS NOTED OTHERWISE, FIELD VERIFY BEFORE CONSTRUCTION.
- CARE MUST BE TAKEN WHEN REMOVING PIPE AROUND LOAD BEARING WALLS. THE WALL OR FOOTING BELOW IS NOT TO BE DESTROYED
- CUT AND PATCH CEILINGS, WALLS AND FLOOR SLAB AS REQUIRED TO FACILITATE PLUMBING RENOVATION. SEE ARCHITECTURAL DRAWINGS FOR PATCHING DETAILS.

## PLUMBING DRAWING INDEX

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REVISIONS

OWNER + LOCATION GRADY HEALTH 80 JESSE HILL JR DRIVE

> JOB NUMBER 24.0128

# PHASE

**CAFETERIA RENOVATION** 

**PLUMBING SYMBOLS,** 

LEGEND, NOTES AND

DATE

SHEET NAME

INDEX

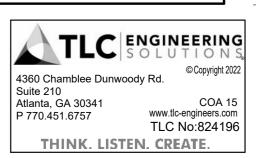
PROJECT

## **PROGRESS BID SET**

11/26/2024

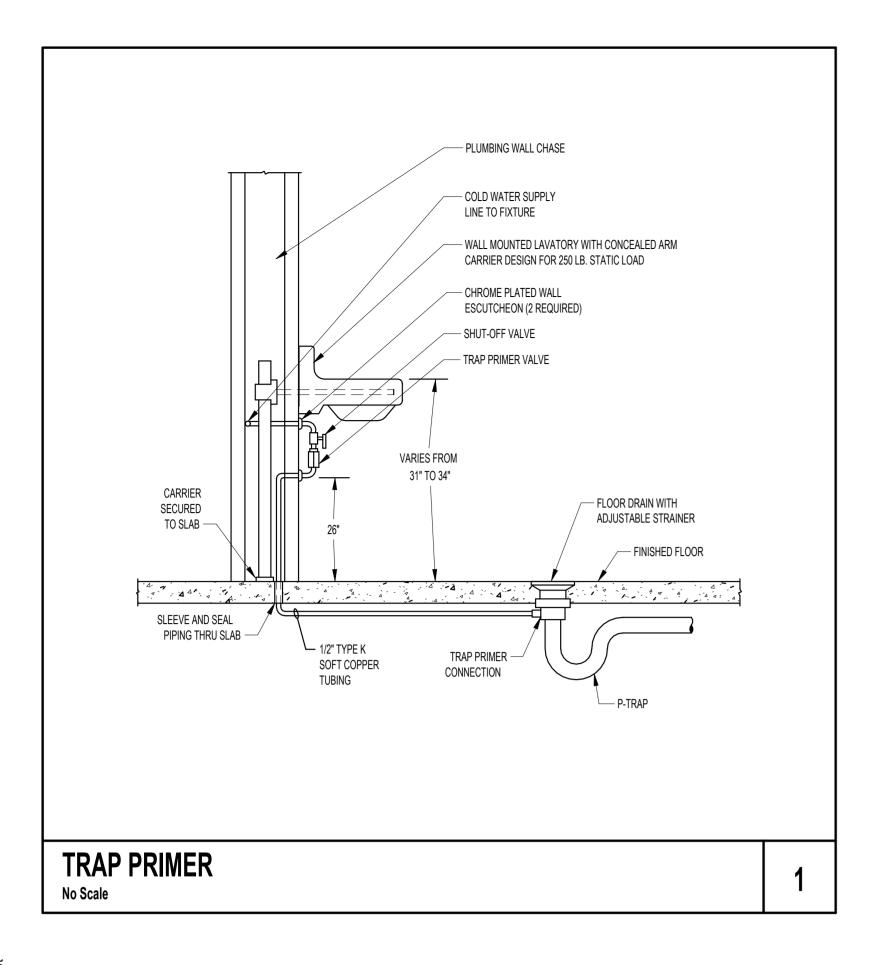






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#### PLUMBING FIXTURE SCHEDULE FIXTURE TRIM FLOW RATE / FLUSH MARK **RATE / FLOW CYCLE** MODEL TYPE MANUFACTURER MODEL MANUFACTURER WC-1 WATER CLOSET AMERICAN STANDARD 2257.101 AMERICAN STANDARD 606B161.002 1.28 GPF WATER CLOSET - ACCESSIBLE AMERICAN STANDARD 2257.101 AMERICAN STANDARD 606B161.002 1.28 GPF WC-2 URINAL (ACCESSIBLE) AMERICAN STANDARD 6590.525 SLOAN 8186-0.125 0.125 GPF LAVATORY INTEGRAL INTEGRAL CHICAGO FAUCET 116.430.AB.1 1.5 GPM L-1 NOTES: 1. WATER CLOSET HARDWARE: TOILET SEAT - BEMIS No. 1655SS, EXTRA HEAVY SOLID PLASTIC WITH STAINLESS STEEL SELF SUSTAINING CHECK HINGE, OPEN FRONT WITHOUT COVER. FIXTURE CARRIER - WATTS ISCA-102-L/R, EXTRA-HEAVY DUTY (1,000 lbs) BARIATRIC CARRIER COMPLIANT WITH ASME A112.6.1M, SINGLE VERTICAL THIN WALL WATER CLOSET CARRIER WITH EPOXY COATED CAST IRON FITTING, NO HUB WASTE (3"), AND VENT (2") CONNECTIONS, EPOXY COATED CAST IRON PATENTED COMPRESSION SEAL FACE PLATE ASSEMBLY, EPOXY COATED CAST IRON FOOT SUPPORTS ADJUSTABLE FOR STANDARD AND WHEELCHAIR HEIGHT, ADJUSTABLE ABS NIPPLE WITH INTEGRAL TEST CAP AND NEOPRANE BOWL GASKET, PLATED HARDWARE AND CHROME CAP NUTS. 2. LAVATORY HARDWARE: STRAINER/TRAP - McGUIRE No. 155A/8902, CHROME PLATED STRAINER, CAST GRID STRAINER WITH 1-1/4" TAILPIECE, PLATED 17 GAUGE 1-1/4" X 1-1/2" BRASS P-TRAP WITH CLEANOUT. (ADA DEPTH SINKS SHALL HAVE OFFSET TAILPIECES McGUIRE No. 155WC/8902). SUPPLIES - MCGUIRE No. 2165CC, 1/2" COMPRESSION X 3/8" COMPRESSION CHROME PLATED ANGLE SUPPLY STOPS WITH CHROME PLATED 12" FLEXIBLE RISERS AND ESCUTCHEONS. INSULATION KIT - EXPOSED SUPPLIES AND TRAPS ARE TO BE PROTECTED WITH INSULATION KITS EQUAL TO PLUMBEREX No. 4333. FIXTURE CARRIER - WATTS No. WCA-411, CONCEALED ARMS FLOOR MOUNTED CARRIER COATED STEEL UPRIGHTS WITH WELDED FEET, CAST IRON ADJUSTABLE HEADERS, STEEL SLEEVES, ALIGNMENT TRUSS AND FASTENERS. 3. <u>SINK HARDWARE</u>:

TRAP - McGUIRE No. 8912, CHROME PLATED 17 GAUGE 1-1/2" X 1-1/2" BRASS P-TRAP WITH CLEANOUT. (ADA DEPTH SINKS SHALL HAVE OFFSET TAILPIECES McGUIRE No. 155WC/8902). SUPPLIES - McGUIRE No. 2165CC, 1/2" COMPRESSION X 3/8" COMPRESSION CHROME PLATED ANGLE SUPPLY STOPS WITH CHROME PLATED 12" FLEXIBLE RISERS AND ESCUTCHEONS.

MOP SINK HARDWARE:

HOSE AND WALL HOOK - STERN WILLIAMS No. T-35, 36" LONG HOSE AND STAINLESS STEEL WALL BRACKET.

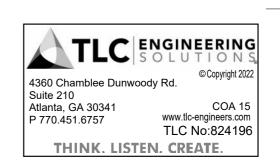
5. ELECTRIC WATER COOLER / DRINKING FOUNTAIN HARDWARE :

FIXTURE CARRIER - WATTS No. CA-431-1, FLOOR MOUNTED BI-LEVEL WATER COOLER CARRIER WITH HEAVY GAUGE STEEL UPRIGHTS WITH INTEGRAL WELDED FEET, UNIVERSAL STEEL HANGER SUPPORT PLATE, AND PLATED HARDWARE.

6. URINAL HARDWARE:

FIXTURE CARRIER - WATTS No. CA-321, FULLY ADJUSTABLE URINAL CARRIER WITH HEAVY GAUGE STEEL OFFSET UPRIGHTS, ADJUSTED TO ACCESSIBLE HEIGHT.

SANITARY DRAIN SCHEDULE				
MARK	DESCRIPTION	MANUFACTURER	MODEL	SPECIFICATION
FD-1	FLOOR DRAIN (6" SQUARE NICKEL BRONZE STRAINER - CAST IRON BODY)	ZURN	Z-415-P-6" X 6" TOP-VP	COATED CAST IRON BODY WITH BOTTOM OUTLET, COMBINATION INVERTIBLE M CLAMP AND ADJUSTABLE TYPE "S" NICKEL BRONZE STRAINER, 6" SQUARE TOP, TRAP PRIMER CONNECTION, VANDAL PROOF.



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**P0.02** 

SHEET NUMBER

## **PLUMBING SCHEDULES AND DETAILS**

SHEET NAME

DATE 11/26/2024 JOB NUMBER 24.0128

# **PROGRESS BID SET**

PHASE

#### PROJECT **CAFETERIA RENOVATION**

OWNER + LOCATION GRADY HEALTH 80 JESSE HILL JR DRIVE

MEMBRANE OP, TAPPED FO

REVISIONS

DESCRIPTION/SPECIFICATIONS

VITREOUS CHINA, 1.28 GALLON, FLOOR MOUNTED, SIPHON JET, ELONGATED CLOSET BOWL WITH 1-1/2" TOP SPUD, BOLT CAPS,

VITREOUS CHINA, 1.28 GALLON FLOOR MOUNTED, DIRECT-FED SIPHON JET, ELONGATED CLOSET BOWL WITH 1-1/2" TOP SPUD, FULL

WALL HUNG VITREOUS CHINA, .125 GPF, SIPHON JET URINAL WITH INTEGRAL FLUSHING RIM, INTEGRAL TRAP, 2" FEMALE FLANGED

LAVATORY BOWL PROVIDED AS INTEGRAL PART OF COUNTERTOP BY ARCHITECTURAL, COORDINATE DRAIN CONNECTION AND

FULLY GLAZED TRAPWAY, WITH RIM OF FIXTURE AT 15" AFF.

DUTLET CONNECTION, TOP OF RIM MOUNTED 17" AFF.

FAUCET HOLE INSTALLATION.

GLAZED TRAPWAY, BOLT CAPS WITH RIM OF FIXTURE 16.5" A.F.F.

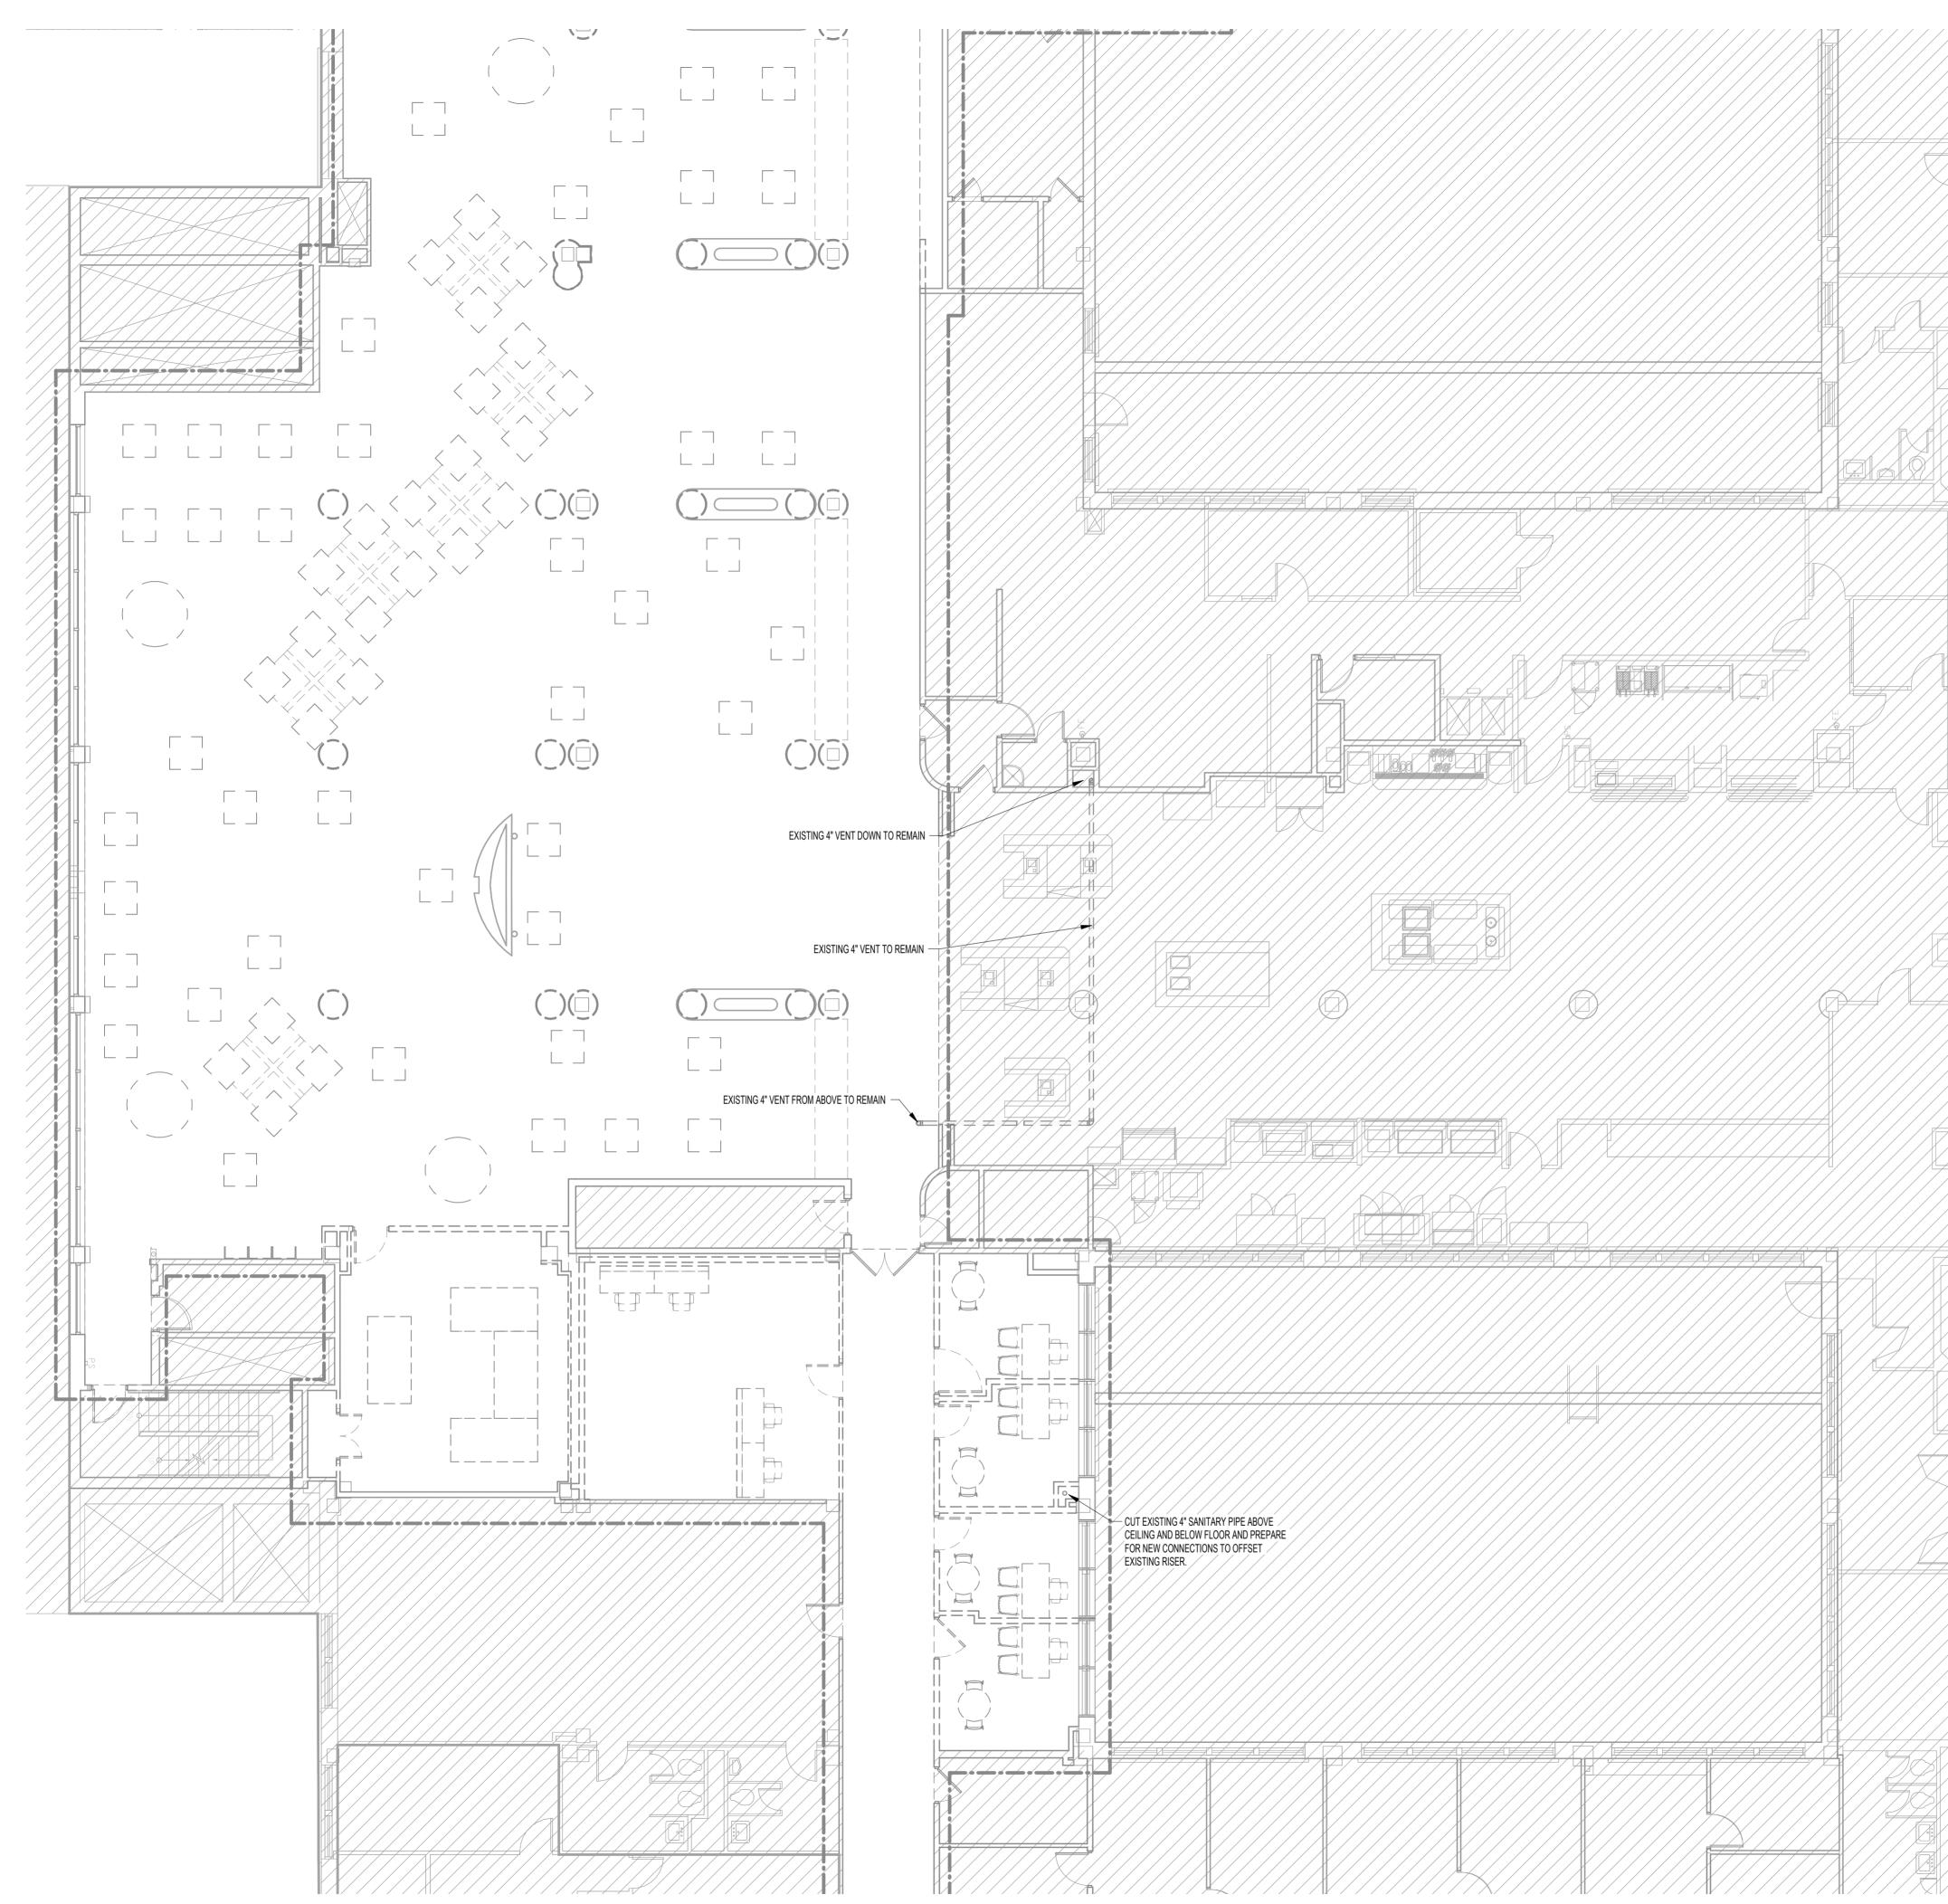
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1 SECOND FLOOR DEMOLITION GRAVITY PIPING DEMOLITION PLAN 1/8" = 1'-0"



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P1.01

SHEET NUMBER

## SHEET NAME **SECOND FLOOR DEMOLITION GRAVITY PIPING DEMOLITION PLAN**

11/26/2024

DATE

JOB NUMBER 24.0128

#### PHASE **PROGRESS BID SET**

PROJECT **CAFETERIA RENOVATION** 

OWNER + LOCATION GRADY HEALTH 80 JESSE HILL JR DRIVE

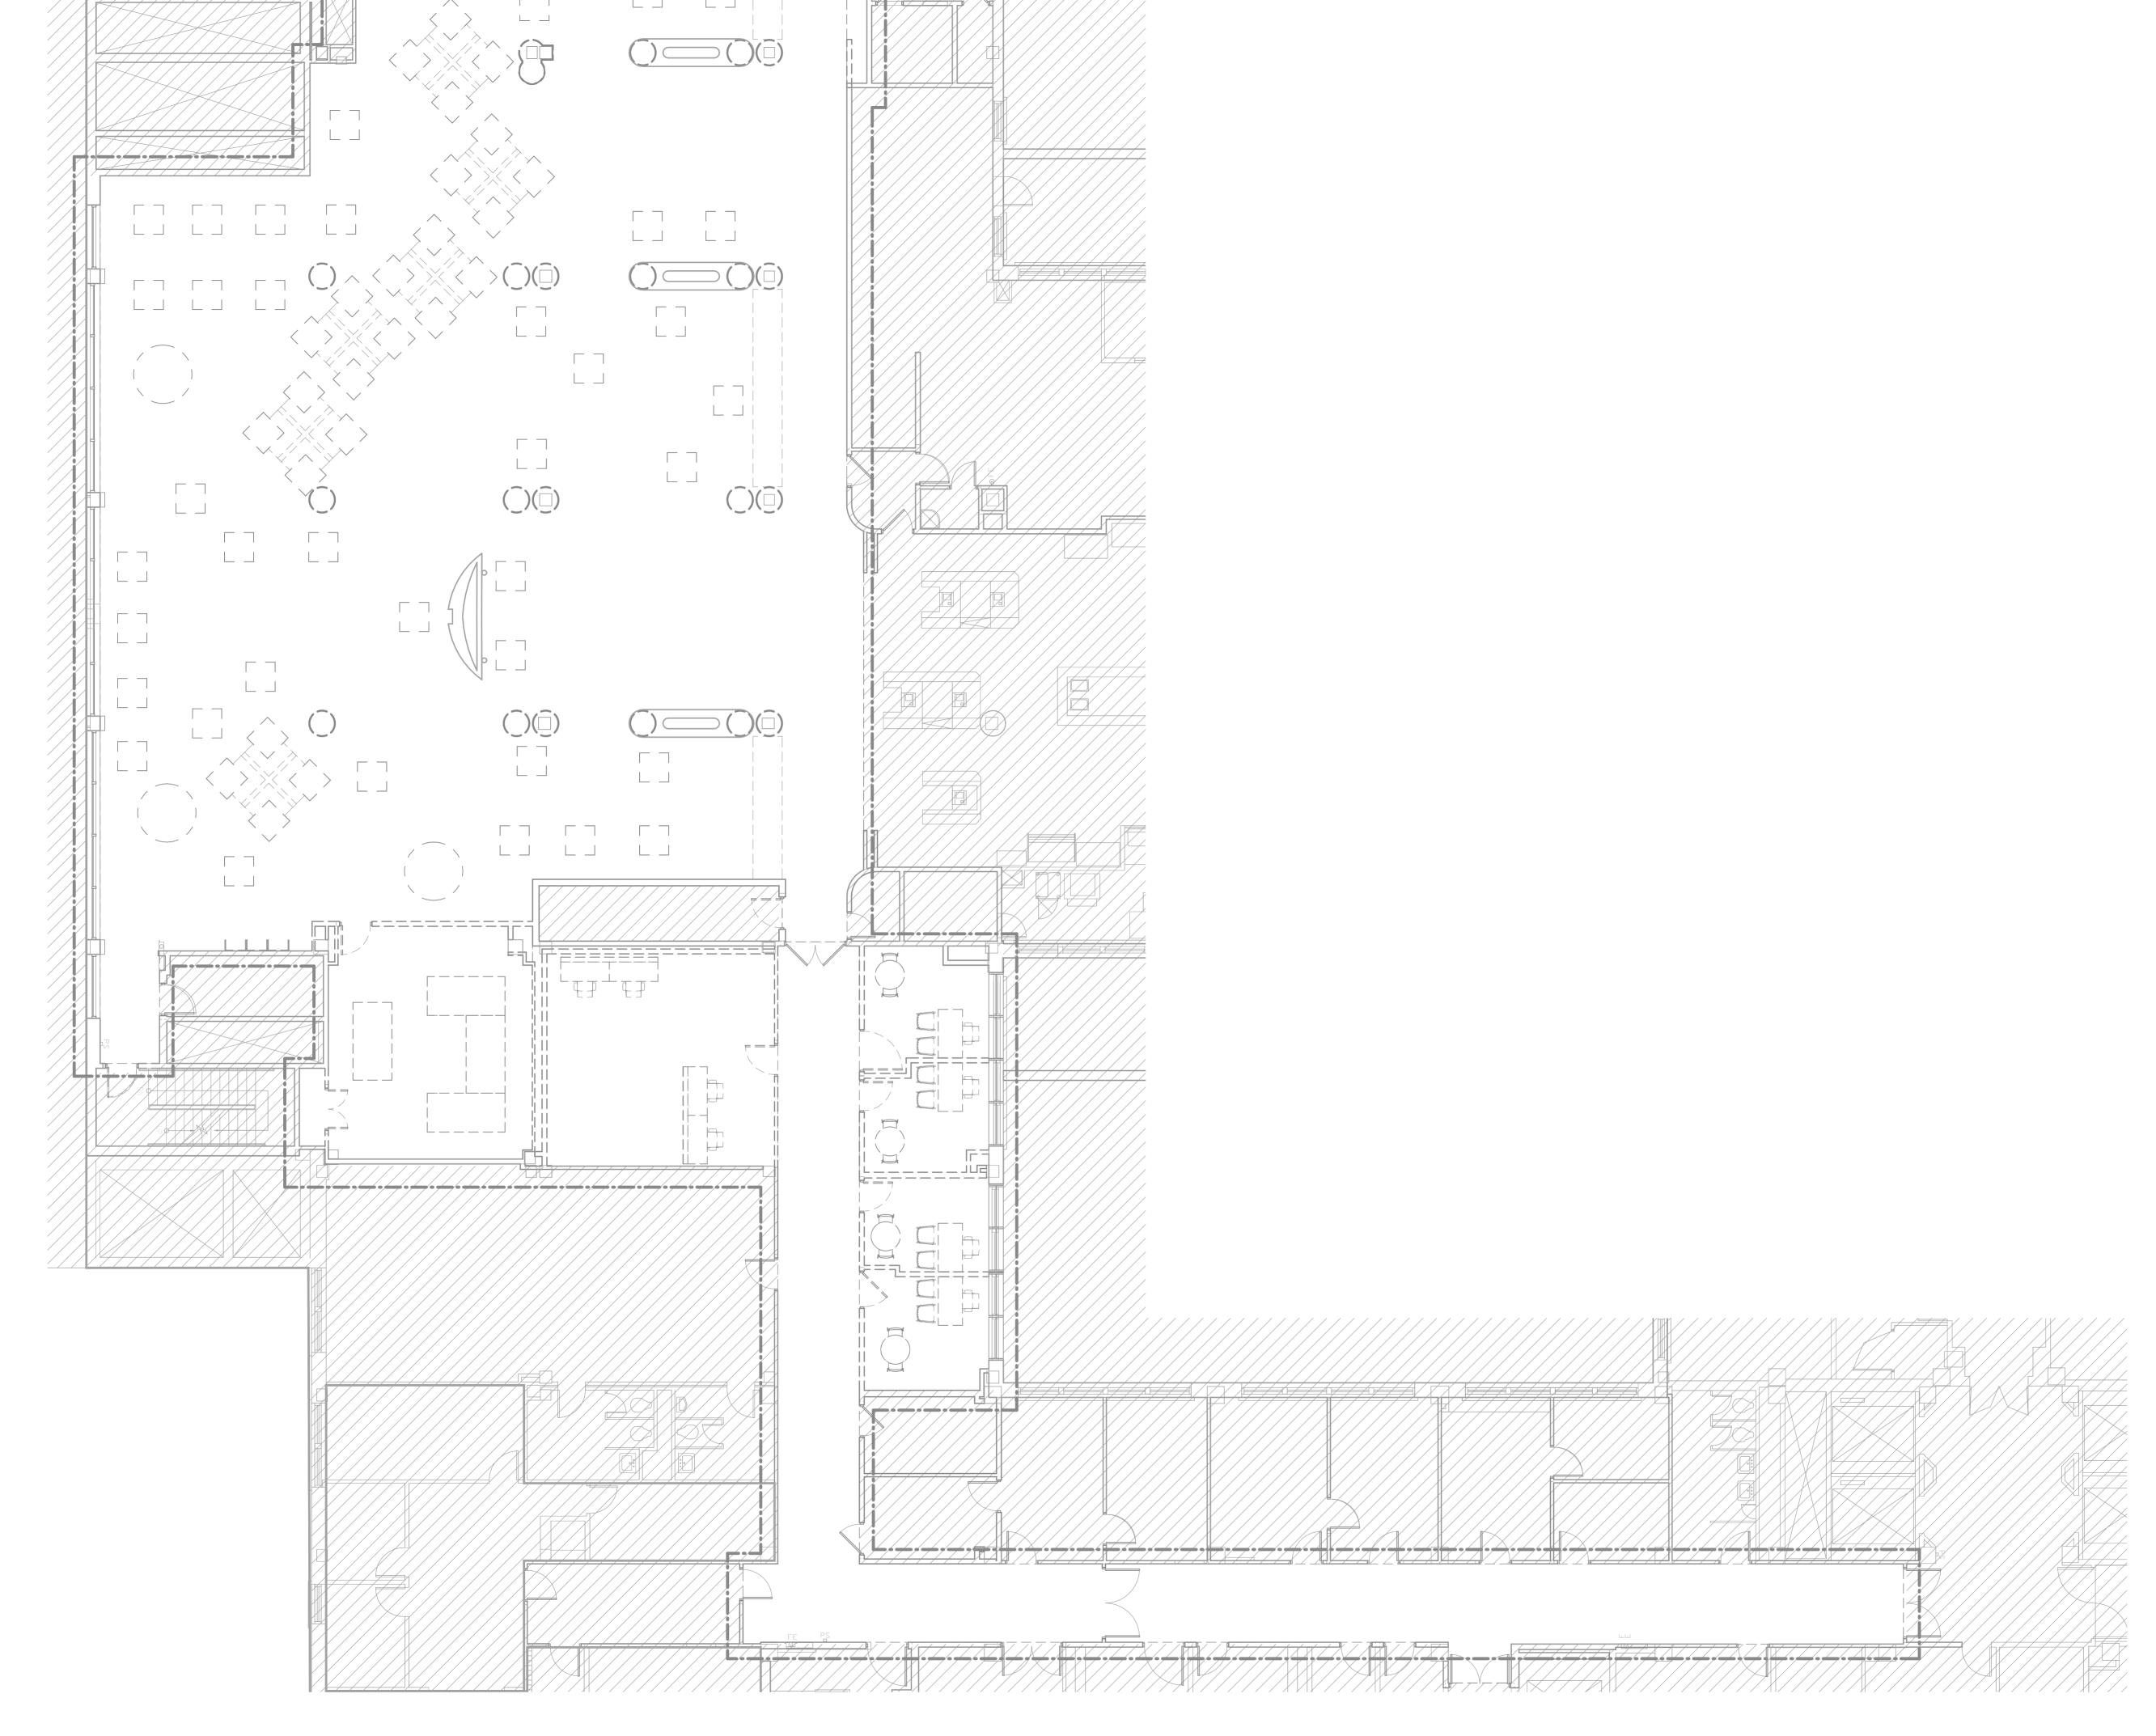
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1 SECOND FLOOR DEMOLITION PRESSURE PIPING DEMOLITION PLAN 1/8" = 1'-0"



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## SHEET NAME **SECOND FLOOR DEMOLITION PRESSURE PIPING DEMOLITION PLAN**

DATE 11/26/2024 JOB NUMBER 24.0128

#### PHASE **PROGRESS BID SET**

PROJECT **CAFETERIA RENOVATION** 

OWNER + LOCATION GRADY HEALTH 80 JESSE HILL JR DRIVE

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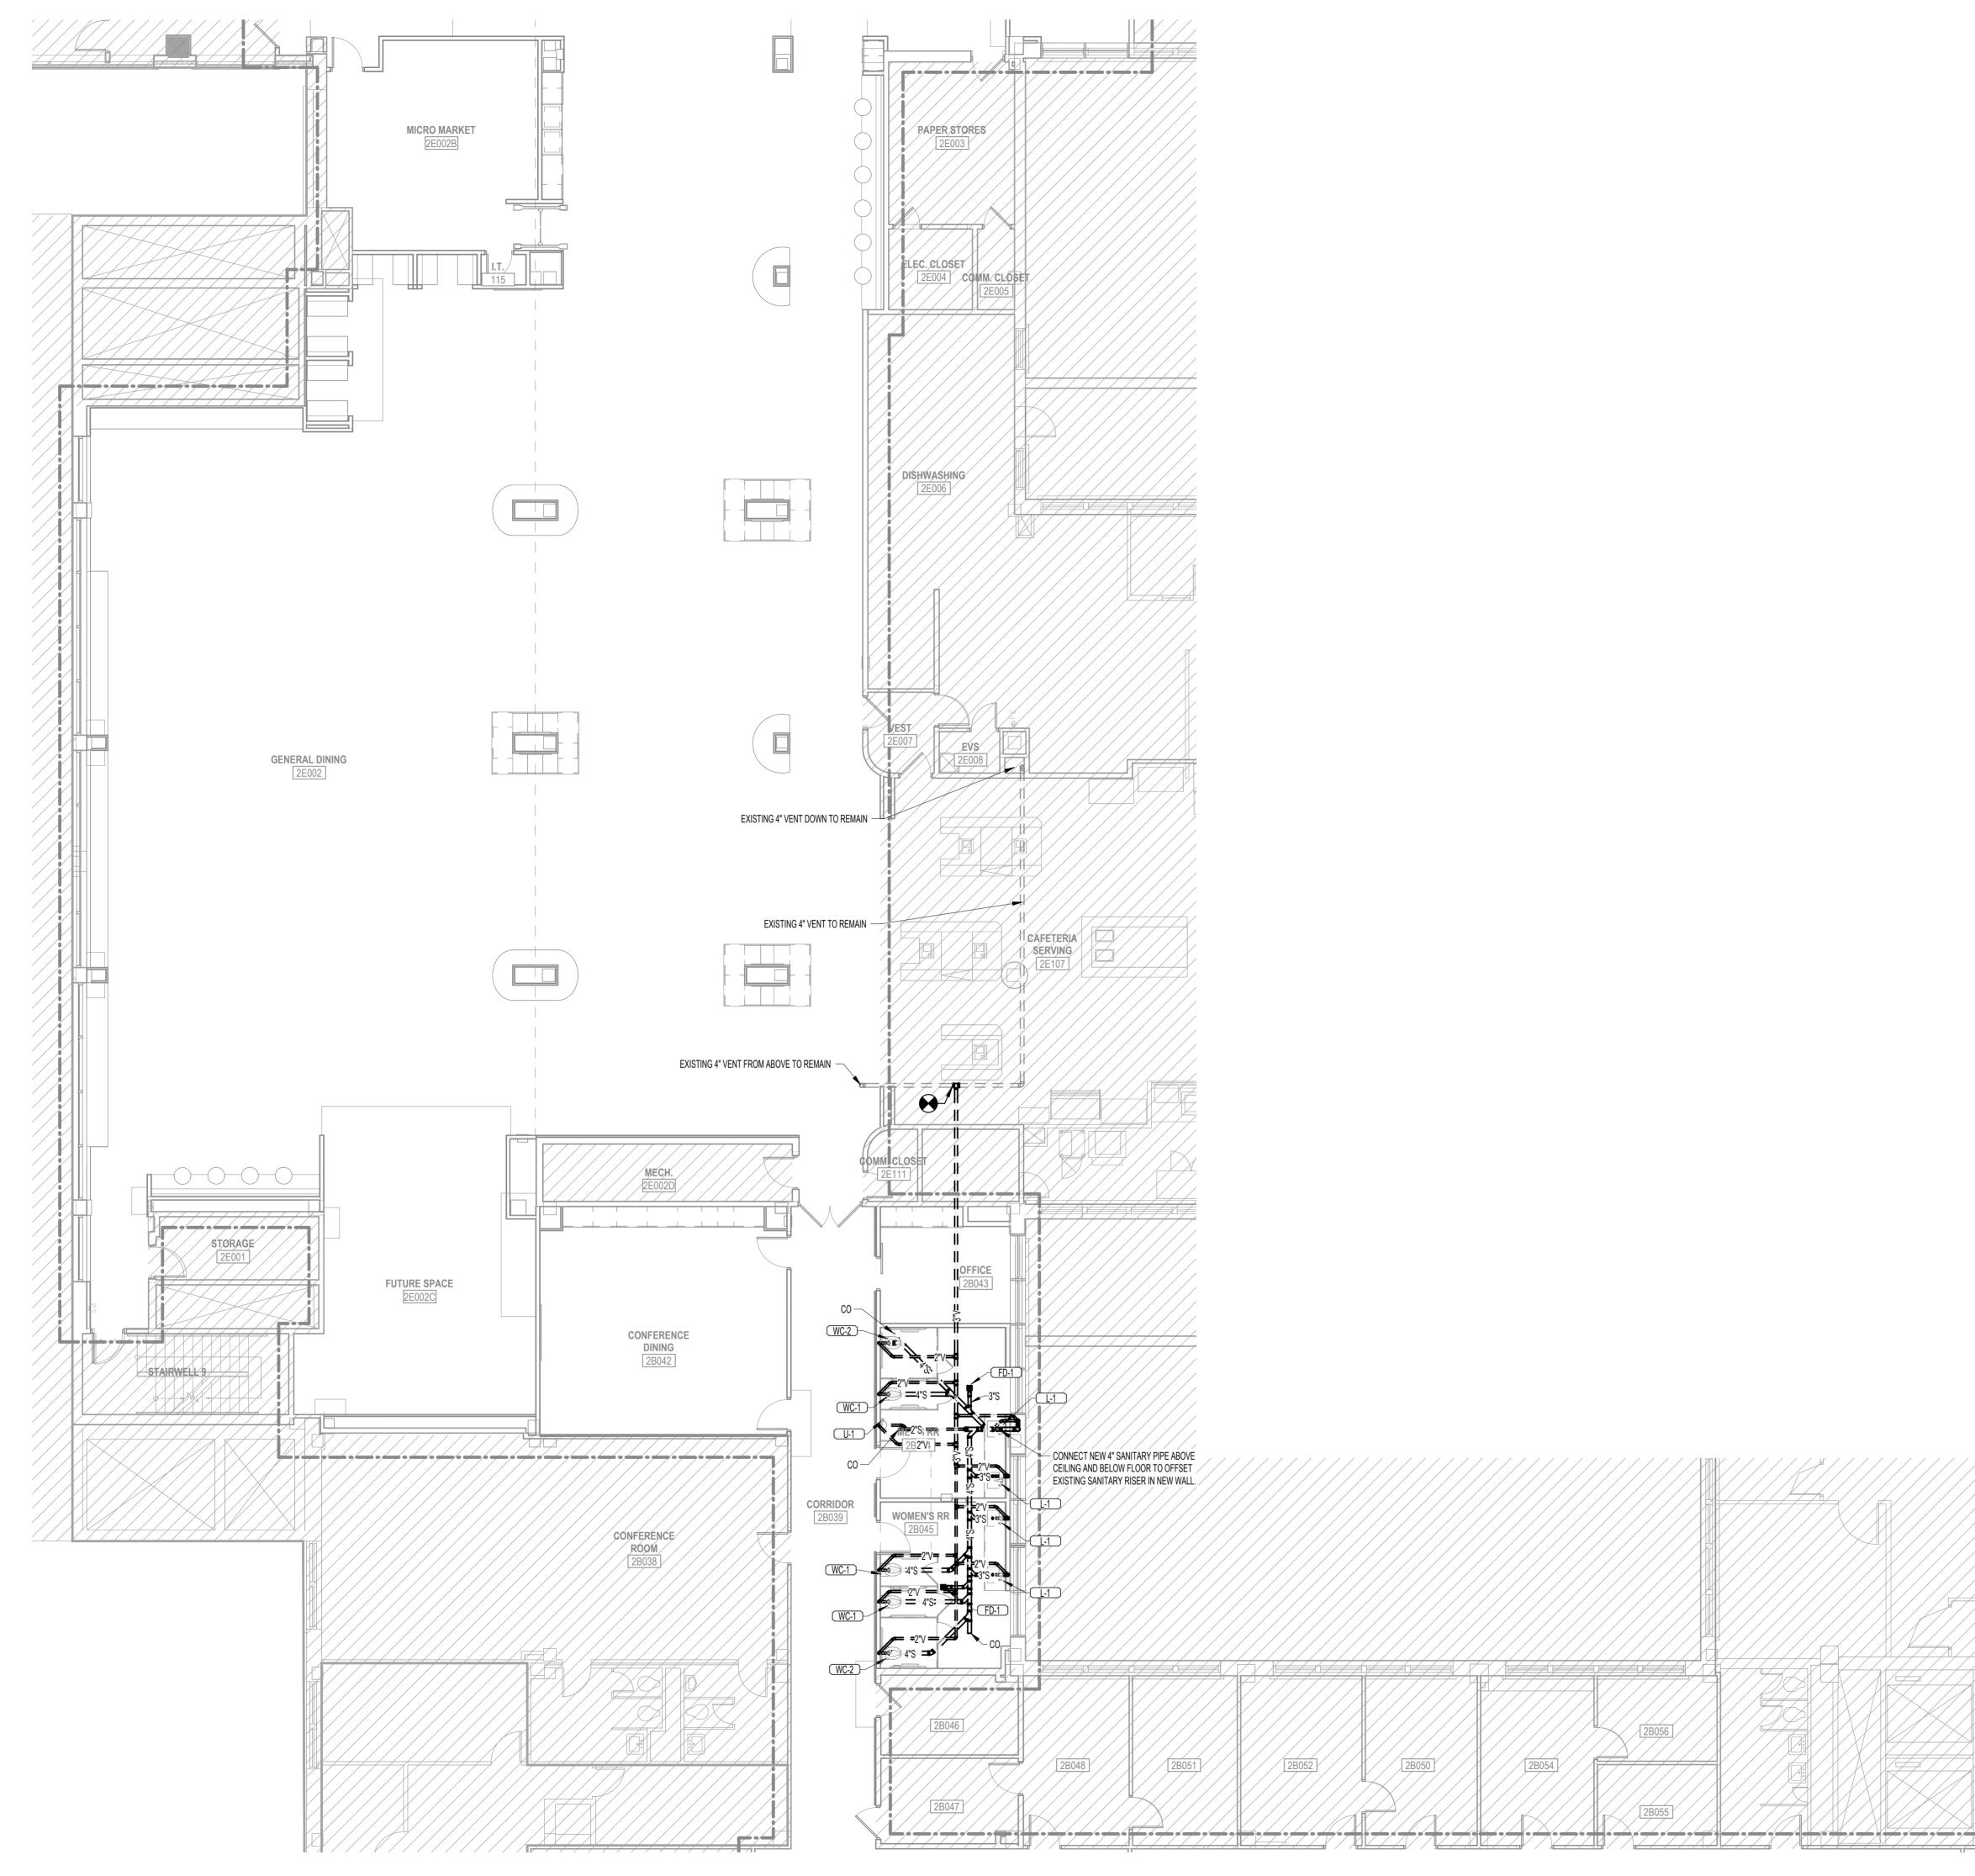
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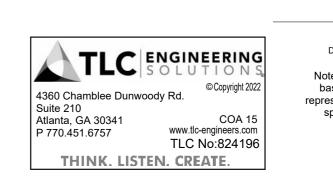
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## **SECOND FLOOR CONSTRUCTION GRAVITY PIPING PLAN**

SHEET NAME

DATE 11/26/2024 JOB NUMBER 24.0128

#### PHASE **PROGRESS BID SET**

PROJECT **CAFETERIA RENOVATION** 

OWNER + LOCATION GRADY HEALTH 80 JESSE HILL JR DRIVE

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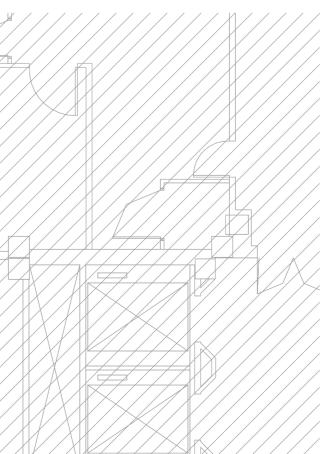
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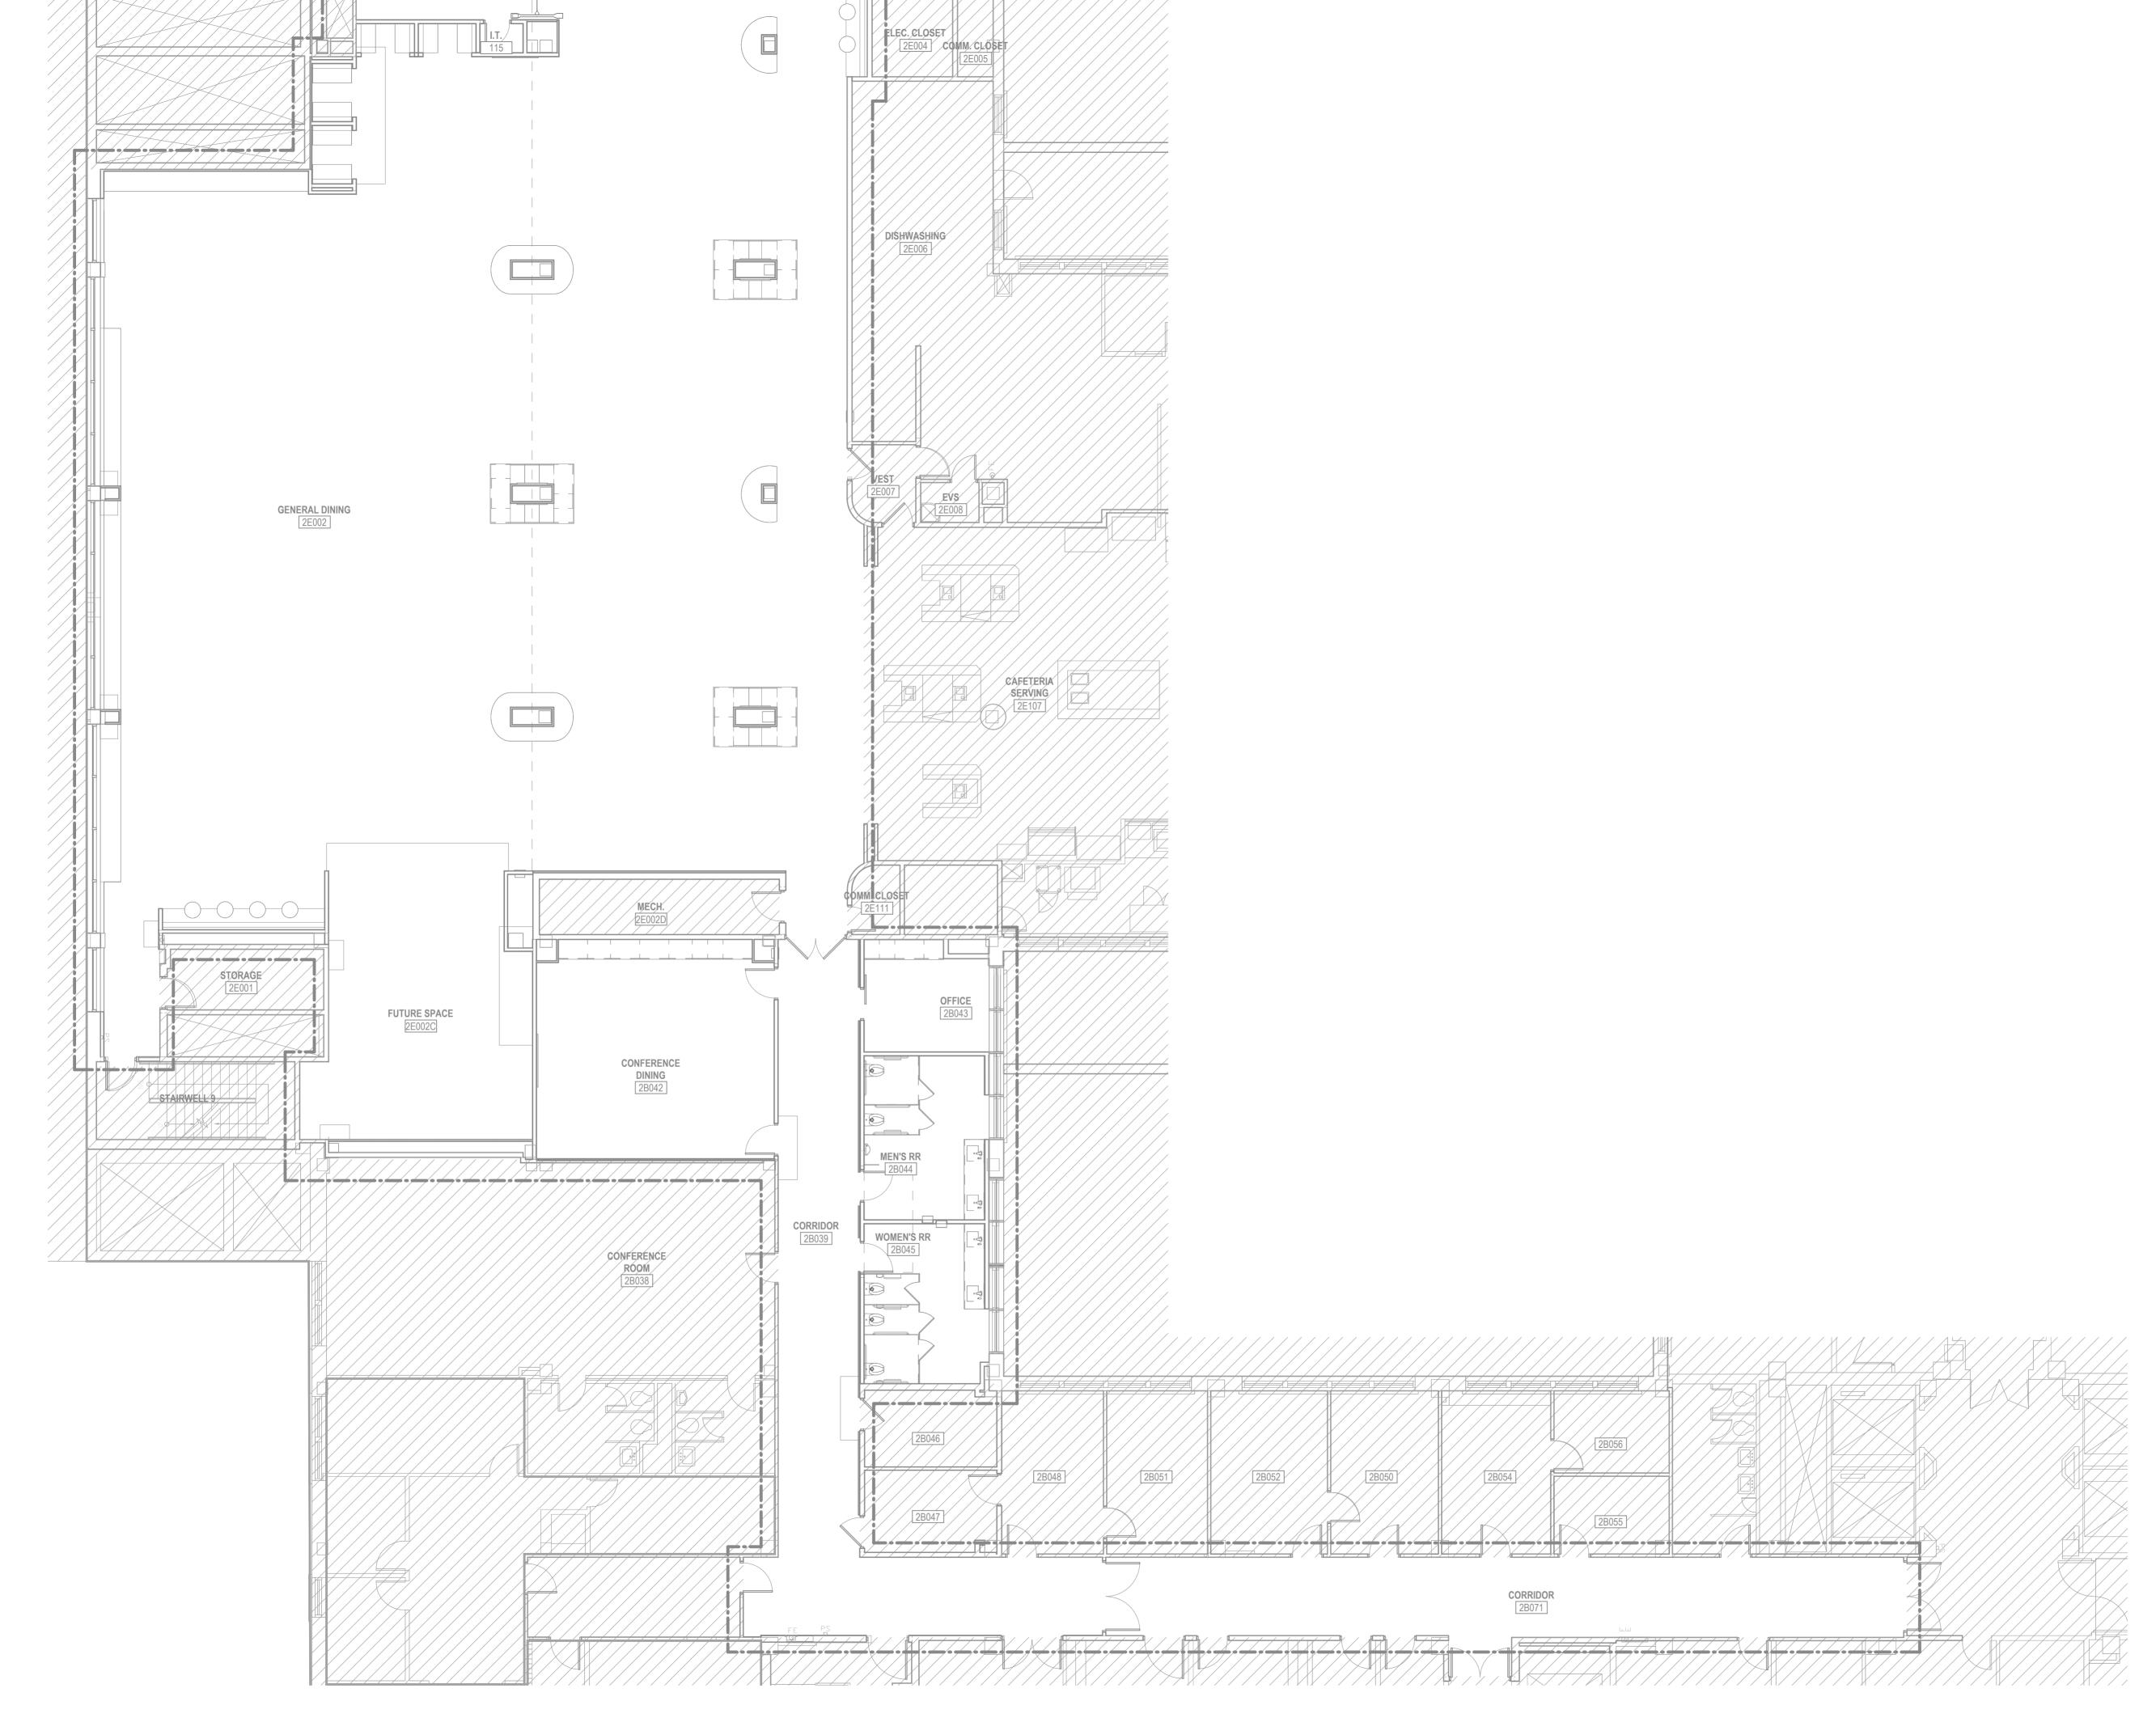
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SHEET NUMBER

## **SECOND FLOOR** CONSTRUCTION **PRESSURE PIPING PLAN**

11/26/2024

SHEET NAME

DATE

JOB NUMBER 24.0128

#### PHASE **PROGRESS BID SET**

PROJECT **CAFETERIA RENOVATION** 

OWNER + LOCATION GRADY HEALTH 80 JESSE HILL JR DRIVE

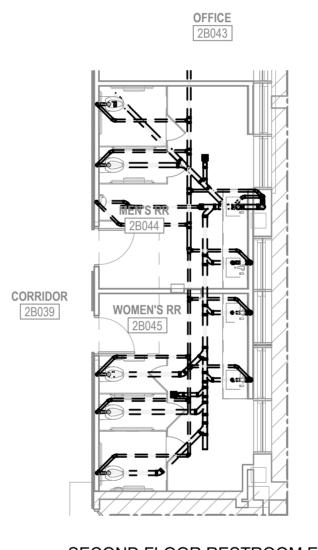
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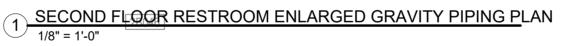
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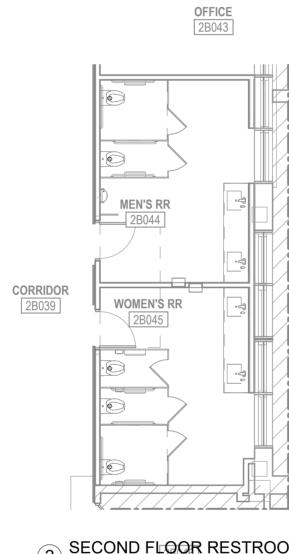
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**P3.01** 

SHEET NUMBER

## **SECOND FLOOR** CONSTRUCTION **ENLARGED PLANS**

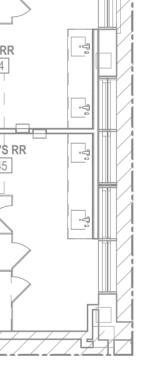
SHEET NAME

DATE 11/26/2024 JOB NUMBER 24.0128

### PHASE **PROGRESS BID SET**

## PROJECT **CAFETERIA RENOVATION**

OWNER + LOCATION GRADY HEALTH 80 JESSE HILL JR DRIVE



2 SECOND FLOOR RESTROOM ENLARGED PRESSURE PIPING PLAN 1/8" = 1'-0"

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